W. EVERGREEN BUSINESS CENTRE



PHASE 1

- PUP SET -

CITY OF HILLSBORO, OREGON

TAX MAP T1N R2E - SECTION 28BA TAX LOT 300

DEVELOPMENT TEAM

APPLICANT/OWNER

NE 30TH AND EVERGREEN 1. LLC 4804 NW BETHANY BLVD. SUITE 1-2, PMB 212 PORTLAND, OREGON 97229 ATTN: BRAD TAGGART PH. (503)914-7166

CIVIL ENGINEER

KITTREDGE ENGINEERS 6565 SW 207TH AVENUE ALOHA, OR 97078 ATTN: CHRIS KITTREDGE, PE PH:(503)708-3942

SURVEYOR

NW SURVEYING, INC. 1815 NW 169TH PLACE BEAVERTON, OREGON 97006 ATTN: CLINT STUBBS, PLS PH:(503)848-2127

ARCHITECT

KERRY W. VANDERZANDEN ARCHITECT, PC 13981 NW MAIN STREET BANKS, OREGON 97106 ATTN: MATT McCOURT PH:(503)324-5220

GEOTECH ENGINEER

GEOTECH SOLUTIONS, INC. 1112 7TH STREET OREGON CITY, OREGON 97045 ATTN:DON RONDEMA, MS, PE, GE PH:(503)657-3487

LIGHTING ENGINEER

NORTHSTAR ELECTRICAL CONTRACTORS 11055 SW CLAY ST. SHERWOOD, OR 97140 ATTN: ADAM SUMINSKI PH: (503) 612-0840

SANITARY, STORM, WATER UTILITIES

CITY OF HILLSBORO PUBLIC WORKS **OPERATIONS** 4415 NE 30TH AVE HILLSBORO, OREGON 97123 PH:(503)615-6509 PH:(503)629-0111 AFTER HOURS

LEGAL DESCRIPTION/ADDRESS

TAX MAP 1N2 28BA, TAX LOT 300 LOCATED AT THE SE CORNER OF NW EVERGREEN RD AND NW 30TH AVE.

PROPOSED USE

CONSTRUCTION OF 3 NEW INDUSTRIAL BUILDINGS BUILT IN 2 PHASES. ONE WAREHOUSE BUILDING WILL BE BUILT IN PHASE 1 AND TWO INDUSTRIAL USE BUILDINGS WILL BE BUILT IN PHASE 2. THESE PLANS ADDRESS PHASE 1 ONLY.

SITE ZONING

I-P - INDUSTRIAL PARK

SITE AREA

4.345 ACRES = 189,256 S.F. - BEFORE R/W DEDICATION

VERTICAL DATUM:

ELEVATION DATUM IS WASHINGTON COUNTY, BASED ON BENCHMARK NO. 530, BEING A BRASS DISK SET IN A MONUMENT BOX FOR THE DONATION LAND CLAIM CORNER LOCATED IN THE CENTER OF THE INTERSECTION BETWEEN NW EVERGREEN PARKWAY AND NW SHUTE ROAD. THE BENCHMARK HAS AN ELEVATION OF 214.08 FEET ON THE NGVD 1929 DATUM.



VICINITY MAP

SHEET INDEX

C100. COVER SHEET

C101. GENERAL CONSTRUCTION NOTES

C102 GENERAL CONSTRUCTION NOTES

C103. EXISTING CONDITIONS

C104. PHASE 1 AND PHASE 2 OVERALL SITE PLAN

C105. SITE PLAN AND TYPICAL SECTIONS

C106. PHASE 1 PROPOSED SITE GRADING PLAN

C107. STORM SEWER PLAN

C108. SANITARY SEWER AND WATER PLAN

-C109. NE 30TH AVE. PLAN AND PROFILE

C109B. DRIVEWAY DETAILS

C110. CITY OF HILLSBORO STANDARD DETAILS

C111. CITY OF HILLSBORO STANDARD DETAILS

C112. CITY OF HILLSBORO STANDARD DETAILS C113. CITY OF HILLSBORO STANDARD DETAILS

C114. CLEAN WATER SERVICES STANDARD DETAILS

C115 CLEAN WATER SERVICES STANDARD DETAILS

C116. CLEAN WATER SERVICES STANDARD DETAILS C117. MISCELLANEOUS DETAILS

ADS DETENTION SYSTEM DETAILS

L-101 LANDSCAPE PLAN SOUTH

L-102 WATER QUALITY PLANTING & DETAILS

I-103 SOUTH WATER QUALITY PLANTING PLAN



THIS DESIGN COMPLIES WITH ORS 92.044 (7) IN THAT NO UTILITY INFRASTRUCTURE IS DESIGNED TO BE WITHIN ONE (1) FOOT OF A SURVEY MONUMENT LOCATION SHOWN ON A SUBDIVISION OR PARTITION PLAT. NO DESIGN EXCEPTIONS NOR FINAL FIELD LOCATION CHANGES SHALL BE PERMITTED IF THAT CHANGE WOULD CAUSE ANY UTILITY INFRASTRUCTURE TO BE PLACED WITHIN THE PROHIBITIED AREA

HILLSBORO CASE FILE #DR-021-19

NW EVERGREEN RD

PHASE 2

PHASE 1

LOCATION MAP

TOTAL IMPERVIOUS AREA = 1.74 ACRES

TOTAL NEW IMPERVIOUS AREA = 0.108 ACRES

LOCATES (48 HOURS NOTICE REQUIRED PRIOR TO EXCAVATION)

TOTAL PERVIOUS AREA = 0.477 ACRES

TOTAL PERVIOUS AREA = 0.022 ACRES

THE CONTRACTOR MUST COMPLY WITH THE REGULATIONS OF O.R.S. 757.541 TO 757.57 IN LOCATION AND PROTECTION OF UNDERGROUND UTILITIES. OREGON LAW REQUIRES YOU TO FOLLOW RULES ADOPTED BY THE OREGON UTILITY NOTIFICATION CENTER. THOSE RULES ARE SET FORTH IN OAR 952-001-0010 THROUGH OAR 952-001-0090. YOU MAY OBTAIN COPIES OF THE RULES BY CALLING THE CENTER.

TOTAL EXISTING SITE AREA (AFTER 11' DEDICATION) = 4.16 ACRES

PROPOSED SITE PERVIOUS/IMPERVIOUS AREAS

EXISTING SITE AREAS

NE 30TH AVE - PHASE 1 FRONTAGE

ONSITE - PHASE 1

4804 NW BETHANY BLVD STE 1-3, PMS 212 PORTLAND, OR 97229

PLAN PREPARED FOR

EVERGREEN 1. LLC

NE 30TH &

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COVER SHEET
- PUP SET- PUP SET
I EVERGREEN BUSINESS C

NE 30TH & EVERGREEN 1, LLC
ANY BLVD. STE1-3, PORTLAND, OR 97229 BRAD TAGG

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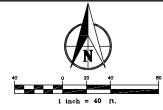
17/20 COH REDLINES

1/20 COH REDLINES

ATE: REVISION



RAWN BY: CPK DESIGNED BY: CPK HECKED BY:



SANITARY SEWER INFORMATION

SS1 MANHOLE RIM = 197.93'

RIM = 197.93' 8" I.E. IN (N) = 182.1' 10" I.E. IN (S) = 182.2' 12" I.E. IN (E) = 181.9' 12" I.E. OUT (W) = 181.8'

(SS2) MANHOLE RIM = 200.88' 8" I.E. IN (N&S) = 184.1' (STUB) 12" I.E. IN (E) = 183.9' 12" I.E. OUT (W) = 183.8'

(SS3) MANHOLE RIM 196.73' 8" I.E. IN (E&W) = 183.5' (STUB) 10" I.E. IN (S) = 183.5' 10" I.E. OUT (N) = 183.3'

(\$\sum_{\text{RIM}} \text{ MANHOLE} \\ \text{RIM} \text{ 199.60'} \\ 8" \text{ I.E. IN (\$\sum_{\text{LE}}\$ \text{ 185.2' (STUB)} \\ 10" \text{ I.E. IN (\$\sigm_{\text{LE}}\$ \text{ 185.2'} \\ 10" \text{ I.E. OUT (\$\sigm_{\text{LE}}\$ \text{ 185.0'} \end{argmatrix}

STORM SEWER INFORMATION

(SD1) MANHOLE

RIM = 197.79'
21" I.E. IN (E) = 193.0'
21" I.E. OUT (W) = 193.0'
(SD2) CURB INLET

SD2) CURB INLET

RIM = 198.64'

GUTTER INLET = 197.99'

I.E. 12" IN (N) = 194.6'

I.E. 12" OUT (S) = 194.2'

SD3 MANHOLE RIM = 198.70' 12" I.E. IN (N) = 194.0' 21" I.E. IN (E) = 193.6'

21" I.E. OUT (W) = 193.5'

SD4) CURB INLET
RIM = 199.31'
GUTTER INLET = 198.67'
12" I.E. IN (N) = 194.1'
21" I.E. DUT (W) = 194.1'
21" I.E. OUT (W) = 194.1'

(SD5) CURB INLET RIM = 200.05' GUTTER INLET = 199.40' 12" I.E. IN (N) = 195.6' 21" I.E. IN (E) = 194.6' 21" I.E. OUT (W) = 194.6'

SD6 MANHOLE RIM = 197.67' 10" I.E. IN (SE) = 194.6' 15" I.E. IN (S) = 194.4' 18" I.F. OLIT (NW) = 194.3'

SD7) CATCH BASIN RIM = 197.32' 10" I.E. OUT (NW) = 194.8'

(SD8) MANHOLE RIM = 198.26' 30" IN (E) 30" OUT (N) FLOWLINE I.E. = 193.9'

GENERAL NOTES

- THE CONTRACTOR SHALL BE REQUIRED TO VISIT SITE PRIOR TO PREBID MEETING TO FAMILIARIZE HIMSELF
 WITH DEMOLITION, GRADING, FTC. AND IMPROVEMENTS TO REMAIN.
- 2. CONTRACTOR SHALL BE RESPONSIBLE TO REMOVE ANY AND ALL ITEMS NOT OTHERWISE LISTED HEREIN THAT CONFLICT WITH THE CONSTRUCTION OF THE PROJECT. CONTRACTOR SHALL CONTACT ENGINEER IMMEDIATELY TO DETERMINE IF ANY ITEMS NOT SHOWN ON THE PLANS MUST BE REMOVED. FAILURE TO DO SO DOES NOT RELIEVE CONTRACTOR OF RESPONSIBILITY AND COST FOR REMOVING ITEMS REQUIRED.
- CONTRACTOR IS RESPONSIBLE FOR REVIEWING (IF APPLICABLE) ALL KNOWN ENVIRONMENTAL
 3. INVESTIGATION STUDIES AND REPORTS PRIOR TO BIDDING. REPORTS ARE INCLUDED IN THE PROJECT
 SPECIFICATIONS. CONTRACTOR TO COORDINATE WITH THE ENVIRONMENTAL ENGINEER ON EXACT AREAS OF
 CONTAMINATION. IF ANY.
- THE CONTRACTOR SHALL TAKE EFFECTIVE ACTION TO PREVENT THE FORMATION OF ANY AIRBORNE DUST NUISANCE, AND SHALL BE RESPONSIBLE FOR ANY DAMAGE RESULTING FROM FAILURE TO FOLLOW WASHINGTON COUNTY QUIDELINES.
- 5. ALL EXISTING REMAINING UTILITIES AND REMAINING IMPROVEMENTS THAT BECOME DAMAGED DURING CONSTRUCTION SHALL BE COMPLETELY RESTORED TO THE SATISFACTION OF THE LOCAL AGENCY AND THE ENGINEER, AT THE CONTRACTOR'S SOLE EXPENSE, IT SHALL BE THE RESPONSIBILITY OF THE CONTRACTOR TO DOCUMENT PRIOR DAMAGES.
- IF ARCHAEOLOGICAL MATERIALS ARE UNCOVERED DURING GRADING, TRENCHING, OR OTHER EXCAVATION, EARTHWORK WITHIN 100 FEET OF THESE MATERIALS SHALL BE STOPPED UNTIL A PROFESSIONAL ARCHAEOLOGIST WHO IS CERTIFIED BY THE SOCIETY OF PROFESSIONAL ARCHAEOLOGY (SOPA) HAS HAD AN OPPORTUNITY TO EVALUATE THE SIGNIFICANCE OF THE FIND AND SUGGEST APPROPRIATE MITIGATION MEASURE, IF THEY ARE DEEMED NECESSARY.

DEMOLITION NOTES:

 SAWCUT AND REMOVE EXISTING ASPHALT PAVEMENT IN PREPARATION FOR PUBLIC 1/2 STREET IMPROVEMENT. FINAL ASPHALT AND ROCK SUBGRADE SECTION TO MATCH NE 30TH STREET SECTION SHOWN ON SHEET C104.

SEE EARLY GRADING PLANS FOR EROSION CONTROL IMPLEMENTATION. THESE ITEMS WILL BE PLACED BEFORE THE PROJECT WORK IN THIS PLAN SET IS IMPLEMENTED.

ALL MANHOLES, CLEANOUTS, VAULTS, RISER BOXES, ETC. NOT SLATED FOR REMOVAL, TO BE ADJUSTED TO FINISH DESIGN GRADE ELEVATIONS.

UTILITY STATEMENT

THE UNDERGROUND UTILITIES SHOWN HAVE BEEN LOCATED FROM FIELD SURVEY INFORMATION AND EXISTING DRAWINGS. THE SURVEYOR MAKES NO GUARANTEE THAT THE UNDERGROUND UTILITIES SHOWN COMPRISE ALL SUCH UTILITIES IN THE AREA, EITHER IN SERVICE OR ABANDONED. THE SURVEYOR FURTHER DOES NOT WARRANT THAT THE UNDERGROUND UTILITIES SHOWN ARE IN THE EXACT LOCATION INDICATED ALTHOUGH HE DOES CERTIFY THAT THEY ARE LOCATED AS ACCURATELY AS POSSIBLE FROM INFORMATION AVAILABLE, THE SURVEYOR HAS NOT PHYSICALLY LOCATED THE UNDERGROUND UTILITIES.

APPROVED TRUEGUYO MRE ANCHO FIRE HYDRANT NCUTHITY POLE WATER METER PEPME PUP19-000060LT PI WATER VALVE DATE WY 02/14/20 TRICAL METER WATER VALUET SANITARY SEWER MANHOLE APOWER JUNGTION BOX STORM SEWER CATCH BASIN STORM SEWER CURB INLET POWER TRANSFORMER TFIF STORM SEWER MANHOLE (1) STREET LIGHT GAS METER TELEPHONE/TELEVISION VAULT GAS VALVE TELEPHONE MANHOLE TELEPHONE/TELEVISION RISER FOUND SURVEY MONUMENT TRAFFIC SIGNAL JUNCTION BOX 63 RIGHT-OF-WAY LINI BOUNDARY LINE PROPERTY LINE CENTERLINE DITCH CURE EDGE OF PAVEMENT FASEMENT FENCE LINE GRAVEL EDGE POWER LINE OVERHEAD WIRE TELEPHONE LINI GAS LINE STORM SEWER LINE SANITARY SEWER LIN WATER LINE SPI CORRIDOR BOUNDARY

BOUNDARY RESOLUTION

THE BASIS OF BEARINGS FOR THIS SURVEY IS THE SOUTH LINE OF THE PROPERTY HOLDING THE MONUMENTS AT 114 AND (\$\frac{122}\) WITH HE RECORD BEARING PER THE PLAT OF "CONRESTIONE BUSINESS PARK". THE MONUMENT AT (\$\frac{122}\) AND RESTREY OF PERSET OF 20.00 FEET FROM THE MONUMENT AT (\$\frac{122}\) AT ITEM STABLISH THE CENTERLINE OF NOW AS OFFSET 20.00 FEET TO THE EAST TO ESTABLISH THE WEST PROPERTY BOUNDARY. THE CENTERLINE OF NW EVERGREEN ROAD WAS ESTABLISHED BY HOLDING THE MONUMENTS AT (\$\frac{122}\) AND (\$\frac{122}\) AND (\$\frac{122}\) ALONG WITH RECORD INFORMATION FROM SURVEY NUMBER 31955. RECORD INFORMATION FROM THE DEDICATION DEED RECORDED AS DOCUMENT NUMBER 2012—2007409 ALONG WITH THE MONUMENTS AT (\$\frac{122}\), AND (\$\frac{122}\) AND (\$\frac{1

NOTES

- 1. THE FIELD WORK FOR THIS SURVEY WAS COMPLETED JULY 5, 2016
- 2. RIGHT-OF-WAY WIDTHS ARE BASED ON THE PLAT, THE ASSESSOR'S MAP AND MULTIPLE RECORDED SURVEYS.
- 3. THERE IS NO PHYSICAL ADDRESS FOR THE SURVEYED PROPERTY.
- 4. THE GROSS PROPERTY AREA IS 4.345 ACRES, MORE OR LESS.
- 5. THE UNDERGROUND UTILITIES ARE BASED ON THE MARKINGS PER LOCATE TICKET NUMBERS 16149184 AND 16159505.
- 6. ELEVATIONS AND CONTOURS ARE BASED ON WASHINGTON COUNTY BENCHMARK NO. 530 BEING A BRASS DISK SET IN A MONUMENT BOX FOR THE DONATION LAID CLAIM CORNER LOCATED IN THE CENTER OF THE INTERSECTION BETWEEN NW EVERGREEN PARKWAY AND NW SHUTE ROAD. THE BENCHMARK HAS AN ELEVATION OF 214.08 FEET ON THE NGYD 1929 DATUM.
- 7. A SLOPE AND PUBLIC UTILITY EASEMENT AFFECTS THE PROPERTY AS SHOWN ALONG THE RIGHT-OF-WAY OF NW EVERGREEN ROAD. THE EASEMENT IS CREATED BY THE DEDICATION DEED RECORDED AS DOCUMENT NUMBER 2012-007409.
- 8. THE ABSENCE OF WETLANDS BEING SHOWN DOES NOT NECESSARILY INDICATE THAT NONE EXIST.

KITTREDGE ENGINEERS, LLC CONSULTING CIVIL ENGINEERING GIVE ENGINEERING

EXISTING CONDITIONS
- PUP SETST EVERGREEN BUSINESS CENTI
NE 30TH & EVERGREEN 1, LLC
ETHANY BLVD. STE1-3, PORTLAND, OR 97229 BRAD TAGGGRT (503)

DATE: REVISION
1/17/20 COH REDLINES
2/1/20 COH REDLINES

NE 30TH & EVERGREEN 1, LLC 4804 NW BETHANY BLVD STE 1-3, PMS 212 PORTLAND, OR 97229



ATE:	1/30/2020
RAWN BY:	CPK
ESIGNED B	r: CPK
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ON TOP, GATE TO HAVE KNOX LOCKS (FOR

6' TALL VINYL COATED CHAIN SWING GATE

W/ 3 STANDS OF BARB WIRE ON TOP. GATE TO HAVE KNOCK LOCKS (FOR MANUAL GATE

MANUAL GATE USE MODEL #3770).

USE MODEL #3770).

SEE SHEET C117 FOR TRENCH DRAIN, VAULT SUMP PUMP AND ELECT. INFORMATION.

13 4' TALL BLACK VINYL FENCE, SEE PIP SET.

14 SIDEWALK TO BE CONSTRUCTED FLUSH WITH AC.

6 HANDICAP SPACE SIGNAGE, SEE DETAIL 4 ON

7 INSTALL WHEEL STOP, TYP OF 5, SEE DETAIL ON SHEET

20 ROLL UP DOOR, TYP

CONSTRUCT HEAVY AC PAVEMENT, SEE DETAIL THIS SHEET.

22 8' PUE, ENDS TO THE NORTH AT CURB.




EGEND EXISTINA PPROVED RE HYDRANT ATER METERY V UT LITY POLE WER VAULT ATER VALVEPUP19-00060 CTRICAL METER

ATER VAULT 02/14/20 ANITARY SEWER MANHOLE WER JUNCTION BOX FORM SEWER CATCH BASIN II CTRICAL MANHOLE VAULT TORM SEWER CURB INLE VER TRANSFORMER TELEPHONE/TELEVISION VAULT TELEPHONE MANHOLE TELEPHONE/TELEVISION RISER FOUND SURVEY MONUMENT ...

PROPERTY LINE EDGE OF PAVEMENT

OVERHEAD WIRE

TELEPHONE LINE STORM SEWER LINE SANITARY SEWER LINE **PROPOSED** CURB AND GUTTER STANDARD CURB PUBLIC UTILITY EASEMENT EXTG. PAVEMENT AREA PROPOSED LIGHT AC PAVEMENT PROPOSED HEAVY AC PAVEMENT

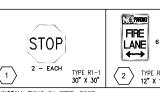

INSTALL SIGNS ON STEEL POS

CONSTRUCTION JOINTS TO BE PLACE @ 15' INTERVAL MAX.
MINIMUM COMPRESSIVE STRENGTH 4000 PSI 2" DEPTH (3/4"-0) LEVELING COURSE (95% ASTM D-1557) CRUSHED BASE ROCK 12" COMPACTED SUBGRADE TYPICAL

TYPICAL CONCRETE PAVEMENT SECTION (PRIVATE)

NOT TO SCALE

CONCRETE PAVEMENT NOTES - PRIVATE

EXPANSION JOINTS SHOULD BE PLACED A MAXIMUM OF 60' IN ANY DIRECTION AND SHOULD BE PLACED WHERE PAVEMENT ABUTS ANY STRUCTURE.

WHERE NOT SPECIFIED HEREIN, CONCRETE PAVEMENT SHOULD COMPLY ODOT STANDARD SPECIFICATIONS.

DOWELS SHOULD HAVE A DIAMETER EQUAL TO 1/8 THE SLAB THICKNESS, BE SPACED ON 12" INTERVALS, AND BE EMBEDDED

RAWN BY

ESIGNED BY: CPK HECKED BY:

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OZ. Z 03 SECTIONS BUSINESS I AND TYPICAL (- PUP SET -REEN BUSIN RGREE Ξ 2 TYPE R7-1 12" X 18"

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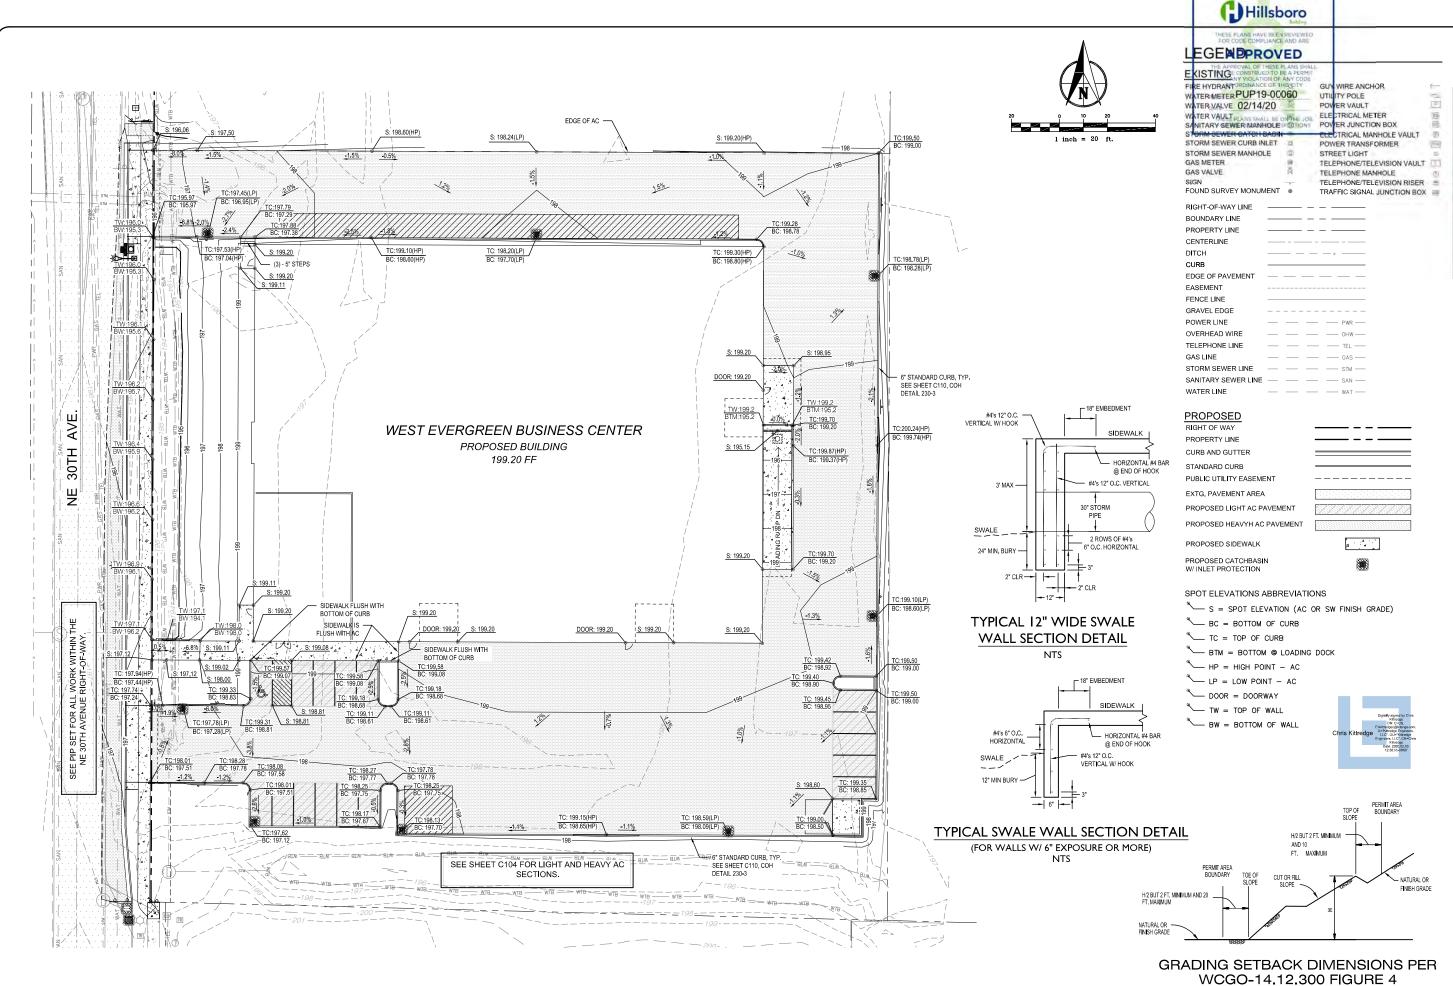
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NE 30TH & EVERGREEN 1, LLC

4804 NW BETHANY BLVD STE 1-3, PMS 212 PORTLAND, OR 97229





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PHASE 1 PROPOSED SITE GRADING PLAN
- PUP SET ST EVERGREEN BUSINESS CENTER WEST


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NE 30TH & EVERGREEN 1, LLC

4804 NW BETHANY BLVD STE 1-3, PMS 212 PORTLAND, OR 97229



DRAWN BY: CPK DESIGNED BY: CPK HECKED BY:

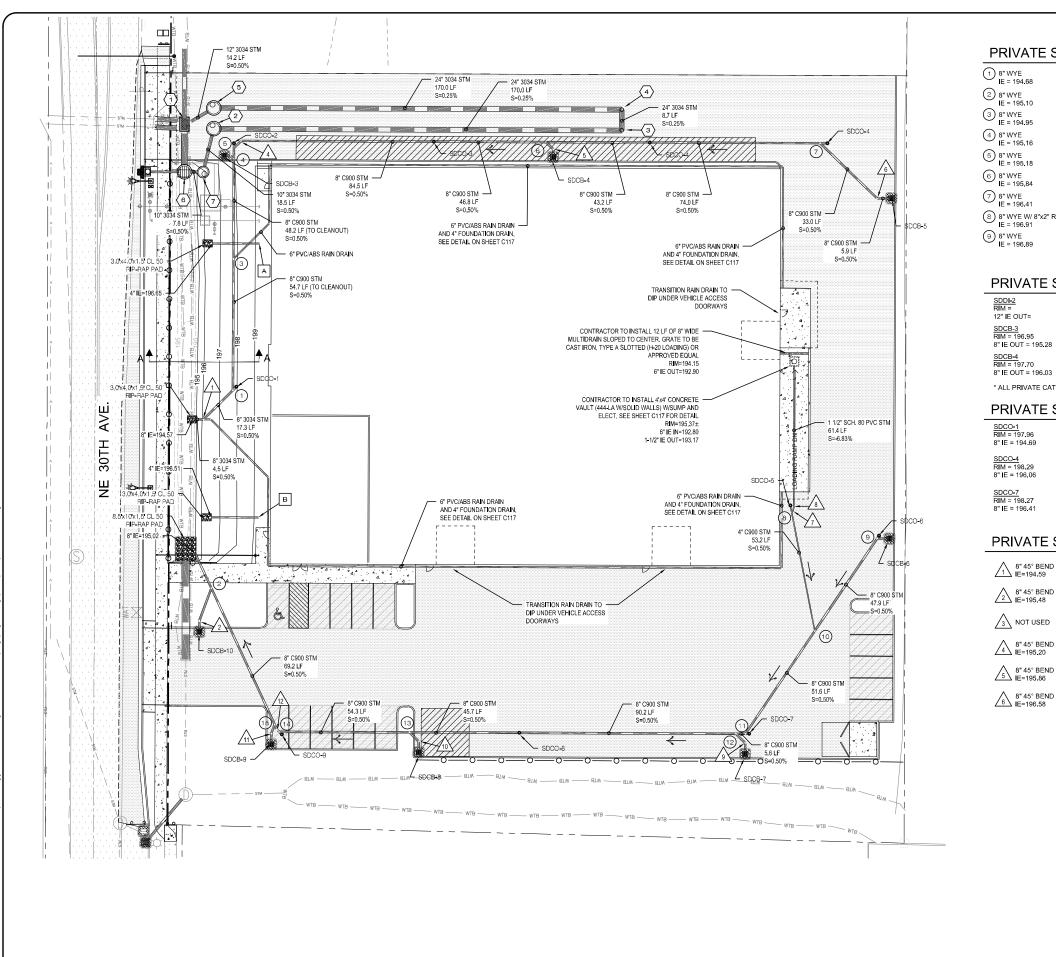

PRIVATE STORM DRAIN BENDS

- 8" WYE W/8"x4" REDUC IE = 196.66
- 2 8" WYE IE = 195.10
- 11) 8" WYE IE = 196.40 12) 8" WYE IE = 196.38

(13) 8" WYE IE = 195.70

8" WYE IE = 195.43

15) 8" WYE IE = 195.41

- 5 8" WYE IE = 195.18
- 6 8" WYE IE = 195.84
- 7 8" WYE IE = 196.41
- 8" WYE W/ 8"x2" REDUCER IE = 196.91
- 9 8" WYE IE = 196.89

PRIVATE STORM DRAIN DATA

<u>SDDI-2</u>	<u>SDCB-5</u>	SDCB-8
RIM =	RIM = 198.28	RIM = 197.70
12" IE OUT=	8" IE OUT= 196.61	8" IE OUT = 196.0
<u>SDCB-3</u>	<u>SDCB-6</u>	<u>SDCB-9</u>
RIM = 196.95	RIM = 198.60	RIM = 197.12
8" IE OUT = 195.28	8" IE OUT = 196.93	8" IE = 195.45
<u>SDCB-4</u>	<u>SDCB-7</u>	SDCB-10
RIM = 197.70	RIM = 198.09	RIM = 197.28
8" IE OUT = 196.03	8" IE OUT = 196.42	8" IE = 195.61

* ALL PRIVATE CATCH BASINS TO BE STANDARD LYNCH TYPE.

PRIVATE STORM CLEANOUT DATA

SDCO-1	SDCO-2	<u>SDCO-3</u>
RIM = 197.96	RIM = 197.17	RIM = 198.47
8" IE = 194.69	8" IE = 195.19	8" IE = 195.60
SDCO-4	SDCO-5	SDCO-6
RIM = 198.29	RIM = 198.78	RIM = 198.68
8" IE = 196.06	8" IE = 196.43	8" IE = 196.90
SDCO-7	SDCO-8	SDCO-9
RIM = 198.27	RIM = 198.22	RIM = 197.34

PRIVATE STORM DRAIN BENDS



- 8" 45° BEND IE=195.88
- 8" 45° BEND IE=195.86 8" 22.5° BEND IE-195.43 8" 45° BEND IE=196.58 8" 22.5° BEND IE=195.42

FOOTING DRAIN LATERAL DATA

A INSTALL 4" SD LATERAL IE = 197.04

Hillsboro

APPROVED

PUP19-00060


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B INSTALL 4" SD LATERAL IE = 196.90

PRIVATE STORM DRAIN DATA

- FOR INFORMATIONAL PURPOSES ONLY, TO BE CONSTRUCTED W/ PIP IMPROVEMENTS
 OLD CASTLE 660 INLET RIM = 196.35' 12" IE IN(NE) = 192.41 30" IE IN(S) = 192.41 18" IE OUT = 192.41 18" IE OUT = 192.41
- 2) 60" WQ MH W/SNOUT AND BOLT DOWN LID RIM = 197.19' 10" IE IN(SW) = 193.36
- 3 18" RISER & LID PER ATTACHED ADS DETAILS RIM = 198.22' IE = 192.93
- 4 18" RISER & LID PER ATTACHED ADS DETAILS RIM = 198.35' IE = 192.91
- 60" FLOW CONTROL MH W/BOLT DOWN LID RIM = 197.30' 24" IE IN = 192.48 12" IE OUT = 192.48
- FOR INFORMATIONAL PURPOSES ONLY, TO BE CONSTRUCTED W/ PIP IMPROVEMENTS 60" SLOPED INLET MH RIM = 193.60' 10" IE IN(W) = 192.71 30" IE OUT(N) = 192.51 10" IE OUT(E) = 193.49 WEIR WALL EL = 194.47 SUMP = 191.01
- 48" FLAT TOP MH W/BOLT DOWN LID RIM = 196.500 10" IE IN = 193,45



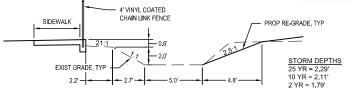

TYPICAL SWALE SECTION A-A

NTS

STORM SEWER PLAN
- PUP SET :VERGREEN BUSINESS C
NE 30TH & EVERGREEN 1, LLC
NUS. STE1-3. PORTLAND, OR 97229 BRAD TAGG Ξ

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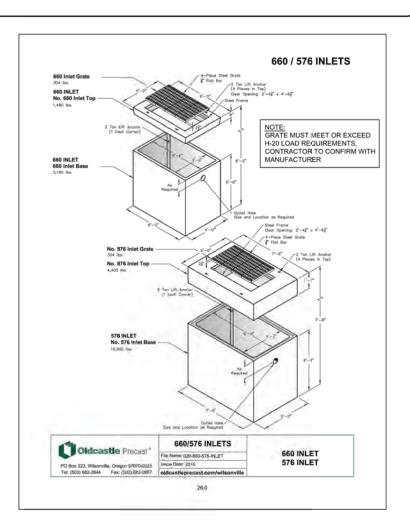
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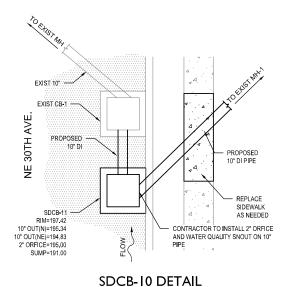
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EVERGREEN 1, LLC 4804 NW BETHANY BLVD STE 1-3, PMS 212 PORTLAND, OR 97229




DATE:	1/30/2020
DRAWN BY:	CPK
DESIGNED BY	: CPK
CHECKED BY	: CPK





NTS

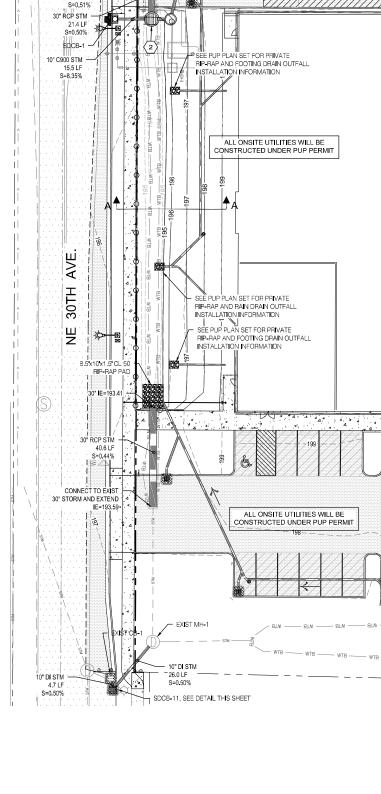

- 18" IE=192.57 CONTRACTOR TO CAP

FOR FUTURE PHASE 2

ALL ONSITE UTILITIES WILL BE CONSTRUCTED UNDER PUP PERMIT

31.9 LF

18" CONC STM 12.7 LF S=0.57%

. 18" CONC STM. 12,4 LF

PUBLIC STORM DRAIN DATEPROVED

OLD CASTLE 660 INLET RIM = 196.35' 12" IE IN(NE) = 192.41 30" IE IN(S) = 192.41 18" IE OUT = 192.41

18" IE OUT = 192.41

SEE DETAIL THIS SHEET

VEIR WALL EL = 194.47




PUBLIC STORM DRAIN DATA


SDCB-1 (CG-30) TC = 195.83 10" IE OUT = 194.00

EXIST MH-1 RIM = 198.26 10" IE IN(SW) = 194.70 30" IE IN(E) = 194.00 30" IE OUT(N) = 193.80

SDCB-11 (CG-2) RIM = 197.42 10" IE OUT(N)= 195.34 10" IE OUT(NE)=194.83 2" ORFICE IE=195.00 SUMP EL=191.00


EXIST CB-1 (CG-2) RIM = 197.32 10" IE IN(S)= 195.32 10" IE OUT(NW)=194.8

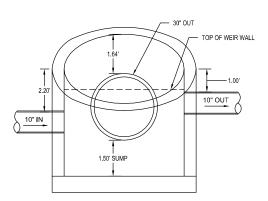

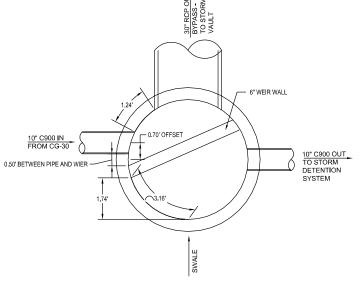

60" SLOPED INLET MH DETAIL



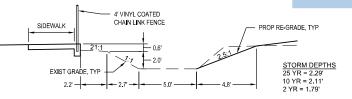

TYPICAL SWALE SECTION A-A

ENGINEERS, 1 RING ULTI CONS CIVIL ENG 6565 SW 21 KITTRED

CENTER STORM SEWER PLAN
- PIP SET
SST EVERGREEN BUSINESS C

NE 30TH & EVERGREEN 1, LLC

BETHANY BLVD. STE1-3, PORTLAND, OR 97229 BRAD TAGG.


WEST DATE: REVISION /17/20 COH REDLINES 2/21/20 COH REDLINES


PLAN PREPARED FOR: NE 30TH &

EVERGREEN 1, LLC 4804 NW BETHANY BLVD STE 1-3, PMS 212 PORTLAND, OR 97229



DATE: DRAWN BY: CPK DESIGNED BY: CPK HECKED BY: CPK

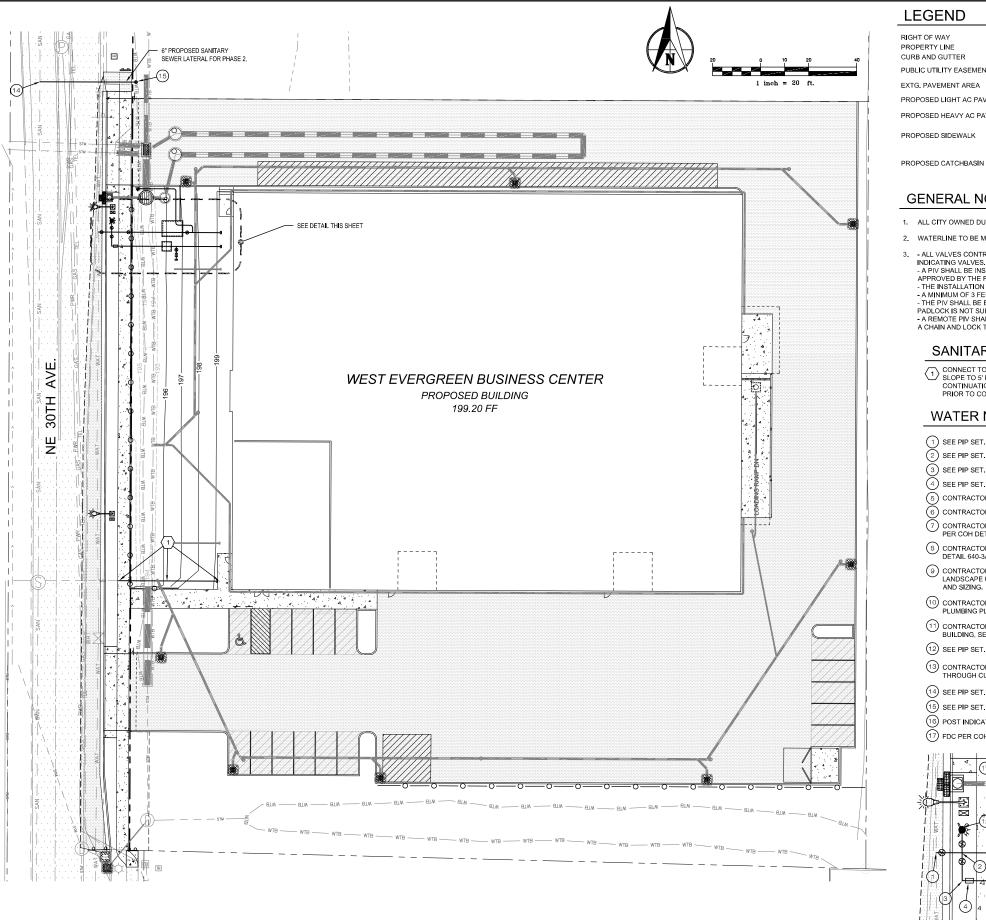

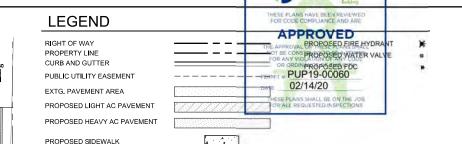

Hillsboro

GENERAL NOTES

- 1. ALL CITY OWNED DUCTILE IRON PIPE TO BE ZINC COATED PER CITY HILLSBORO STANDARDS.
- 2. WATERLINE TO BE MECHANICALLY RESTRAINED FOR FULL PIPE LENGTH ALONG 6" FIRE LINE.
- 3. ALL VALVES CONTROLLING CONNECTIONS TO WATER SUPPLIES AND TO SUPPLY PIPE TO SPRINKLERS SHALL BE LISTED INDICATING VALVES.
- INDICATING VALUES.

 A PIV SHALL BE INSTALLED NOT LESS THAN 40 FEET FROM THE PROTECTED BUILDING, UNLESS AN ALTERNATIVE DESIGN IS APPROVED BY THE FIRE CODE OFFICIAL.

 THE INSTALLATION HEIGHT OF THE PIV SHALL E 32 TO 40 INCHES ABOVE THE FINAL GRADE.
- A MINIMUM OF 3 FEET OF WORKING CLEARANCE SHALL BE MAINTAINED AROUND THE PIV.

 THE PIV SHALL BE ELECTRICALLY SUPERVISED BY A LISTED FIRE ALARM CONTROL UNIT PER THE OREGON FIRE CODE. A PADLOCK IS NOT SUFFICIENT FOR SECURING A VALVE CONTROLLING THE WATER SUPPLY TO A SPRINKLER SYSTEM. - A REMOTE PIV SHALL HAVE A BREAKAWAY PADLOCK SECURING THE REMOVABLE HANDLE. A WALL MOUNTED PIV SHALL HAVE A CHAIN AND LOCK TO PREVENT TAMPERING.


SANITARY LATERAL DATA

CONNECT TO AND EXTEND EXIST 8" LATERAL @ 2% MIN SLOPE TO 5" FROM BUILDING, SEE PLUMBING PLANS FOR CONTINUATION. CONTRACTOR TO VERIFY LOCATION

WATER NOTES

- 1) SEE PIP SET.
- 2 SEE PIP SET.
- (3) SEE PIP SET.
- (4) SEE PIP SET.
- (5) CONTRACTOR TO INSTALL 6" DIP FIRE LINE.
- (6) CONTRACTOR TO INSTALL 2" WIRSBO DOMESTIC LINE.
- 7 CONTRACTOR TO INSTALL 6" FIRE LINE DOUBLE CHECK VALVE ASSEMBLY PER COH DETAIL 640-5B, W/ SUMP PUMP, ELECT. AND SUMP DRAIN.
- $\begin{picture}(60,0)\put(0,0){\line(0,0){10}}\put(0,0){\line(0,0){10}$
- (9) CONTRACTOR TO INSTALL TEE, GATE VALVE AND DOUBLE CHECK VALVE ASSEMBLY FOR LANDSCAPE USE PER COH DETAIL 640-3A. SEE LANDSCAPE PLANS FOR CONTINUATION

- (1) CONTRACTOR TO INSTALL 2" WIRSBO DOMESTIC LINE, CAP 5' FROM BUILDING, SEE PLUMBING PLANS FOR CONTINUATION.
- (12) SEE PIP SET.
- $\stackrel{\textstyle \frown}{\bigcirc}$ CONTRACTOR TO INSTALL 1-1/2" SCH 80 SUMP PUMP DRAIN LINE, WEEP THROUGH CURB.
- 14 SEE PIP SET. (15) SEE PIP SET.
- 16) POST INDICATOR VALVE PER COH DETAIL 640-5B.
- (17) FDC PER COH DETAIL 640-5B.

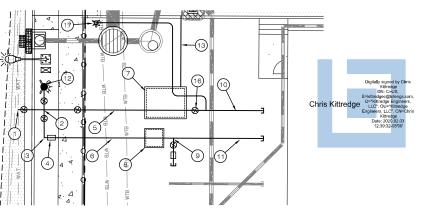

WATER DETAIL

SCALE: 1"=10'

ZZ 03

CENTER ANITARY SEWER AND WATER PLAN - PUP SET -EVERGREEN BUSINESS CEN ST

ATE: REVISION /17/20 COH REDLINES

PLAN PREPARED FOR

NE 30TH &

EVERGREEN 1, LLC 4804 NW BETHANY BLVD STE 1-3, PMS 212 PORTLAND, OR 97229



DRAWN BY: CPK DESIGNED BY: CPK

HECKED BY: